
PROPOSED SECONDARY DWELLING WITH ATTACHED GARAGE AT 21 THIRD AVE, CONDELL PARK NSW 2200

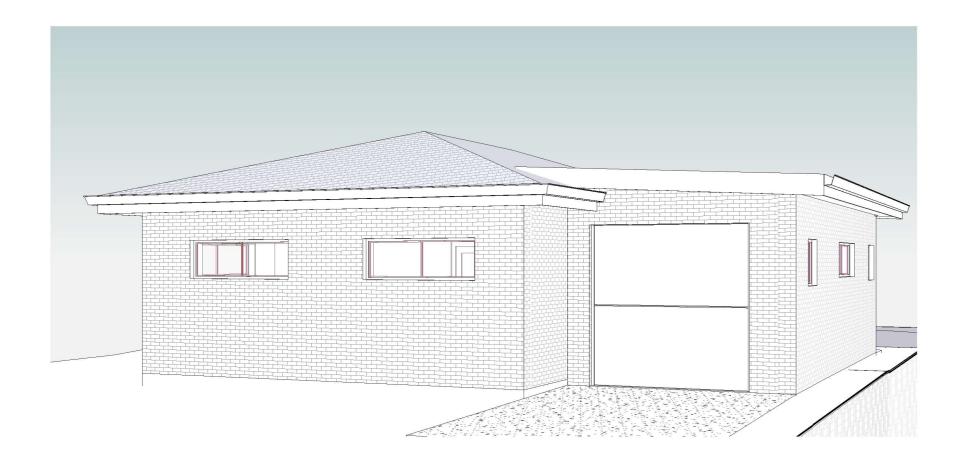


DRAWING SHEETS		
Sheet Number	Sheet Name	
A00	COVER SHEET	
A01	DEMOLITION PLAN, WASTE MANAGEMENT PLAN AND SEDIMENT & EROSION CONTROL PLAN	
A02	SITE PLAN & ROOF PLAN, SITE ANALYSIS PLAN. LANDSCAPING PLAN	
A03	PROPOSED FLOOR PLAN	
A04	ELEVATIONS AND SECTION	
A05	3D MODEL	
A06	SCHEDULE OF MATERIALS & FINISHES	
A07	SHADOW DIAGRAMS - 21st JUN	
A08	BASIX REQUIREMENTS - PART 1	
A09	BASIX REQUIREMENTS - PART 2	
A10	NOTES & SPECIFICATIONS	





COVER SHEET

Η	JOB NUMBER: 22082	DWG NUMBER:	ORIGINAL SIZE:
	DESIGNED BY: A.A.	DATE: 08.12.2023	
	DRAWN BY: A.A.	SCALE: AS SHOWN	

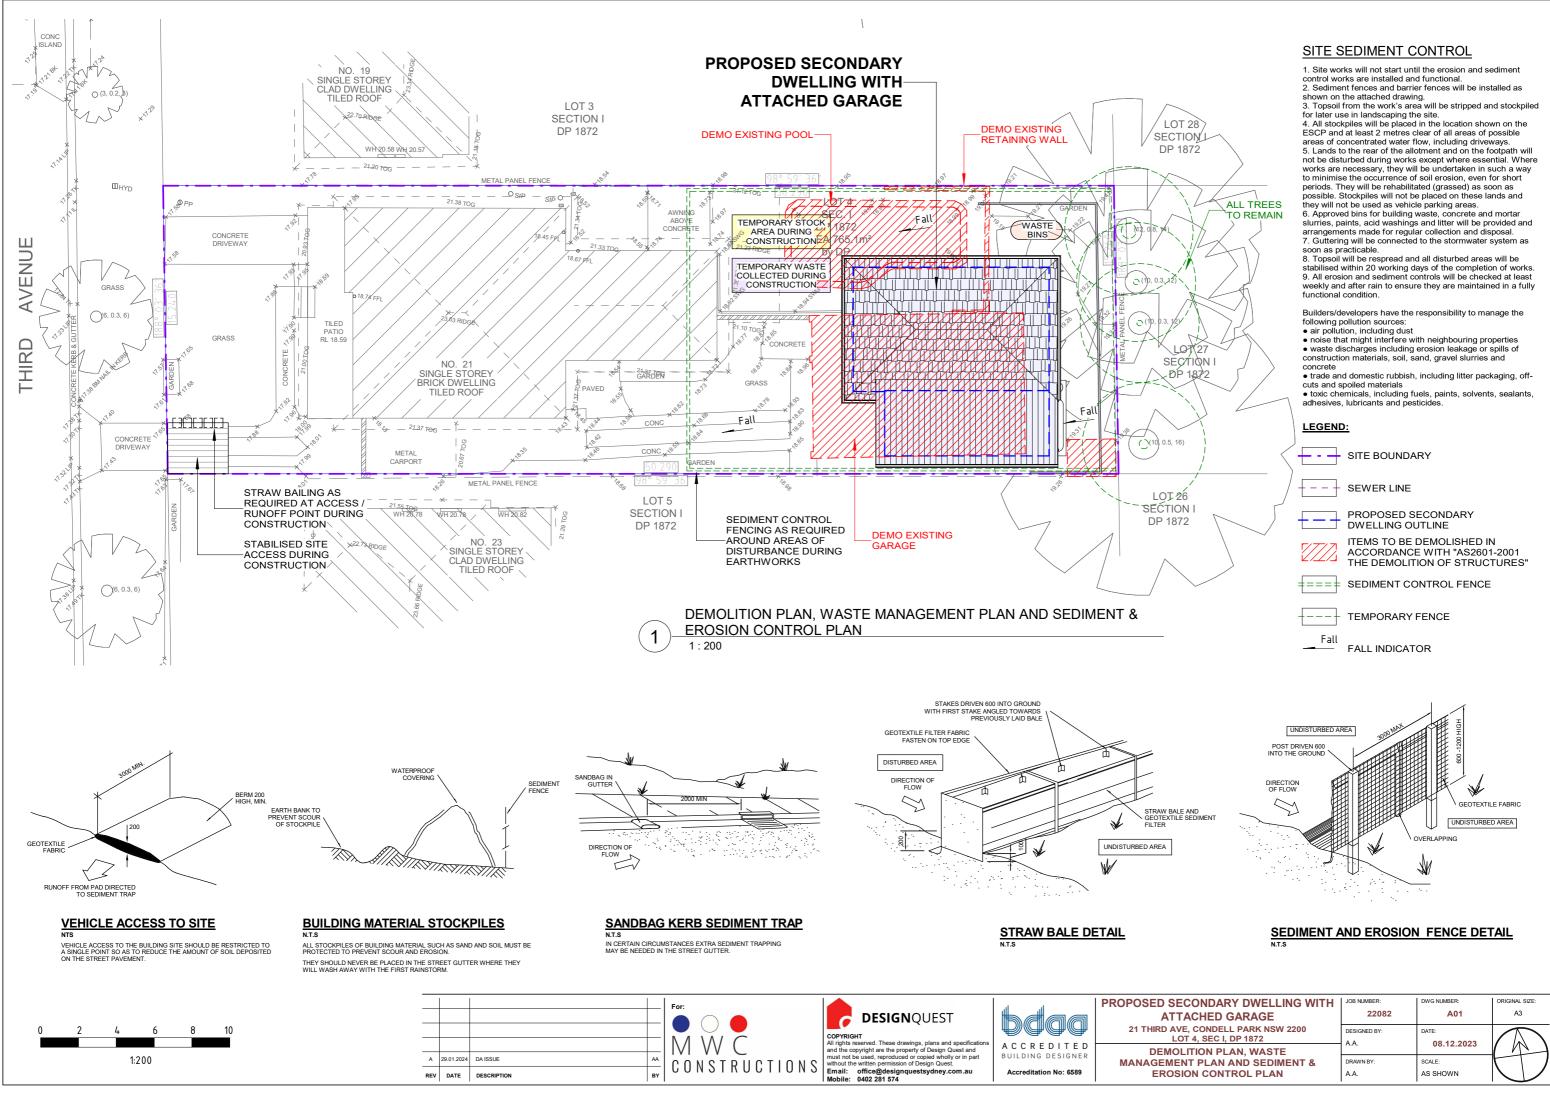

CONSTRUCTIONS

REV DATE DESCRIPTION

MANAGEMENT PLAN AND SEDIMENT &


EROSION CONTROL PLAN

DRAWN BY


A.A.


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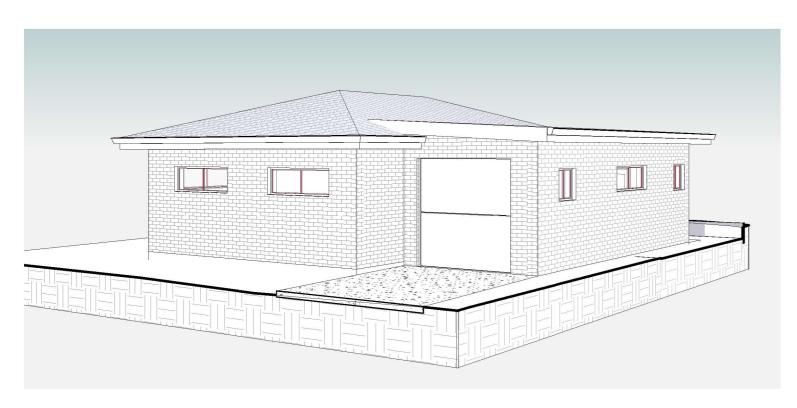
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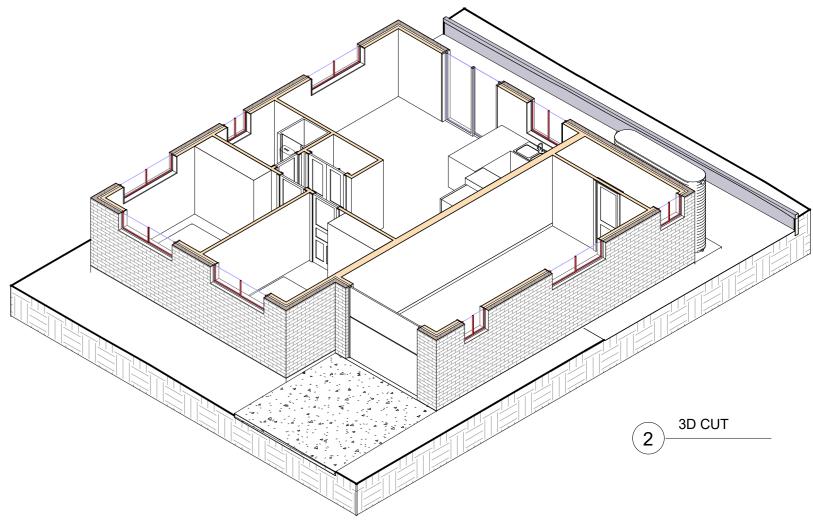
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3D VIEW

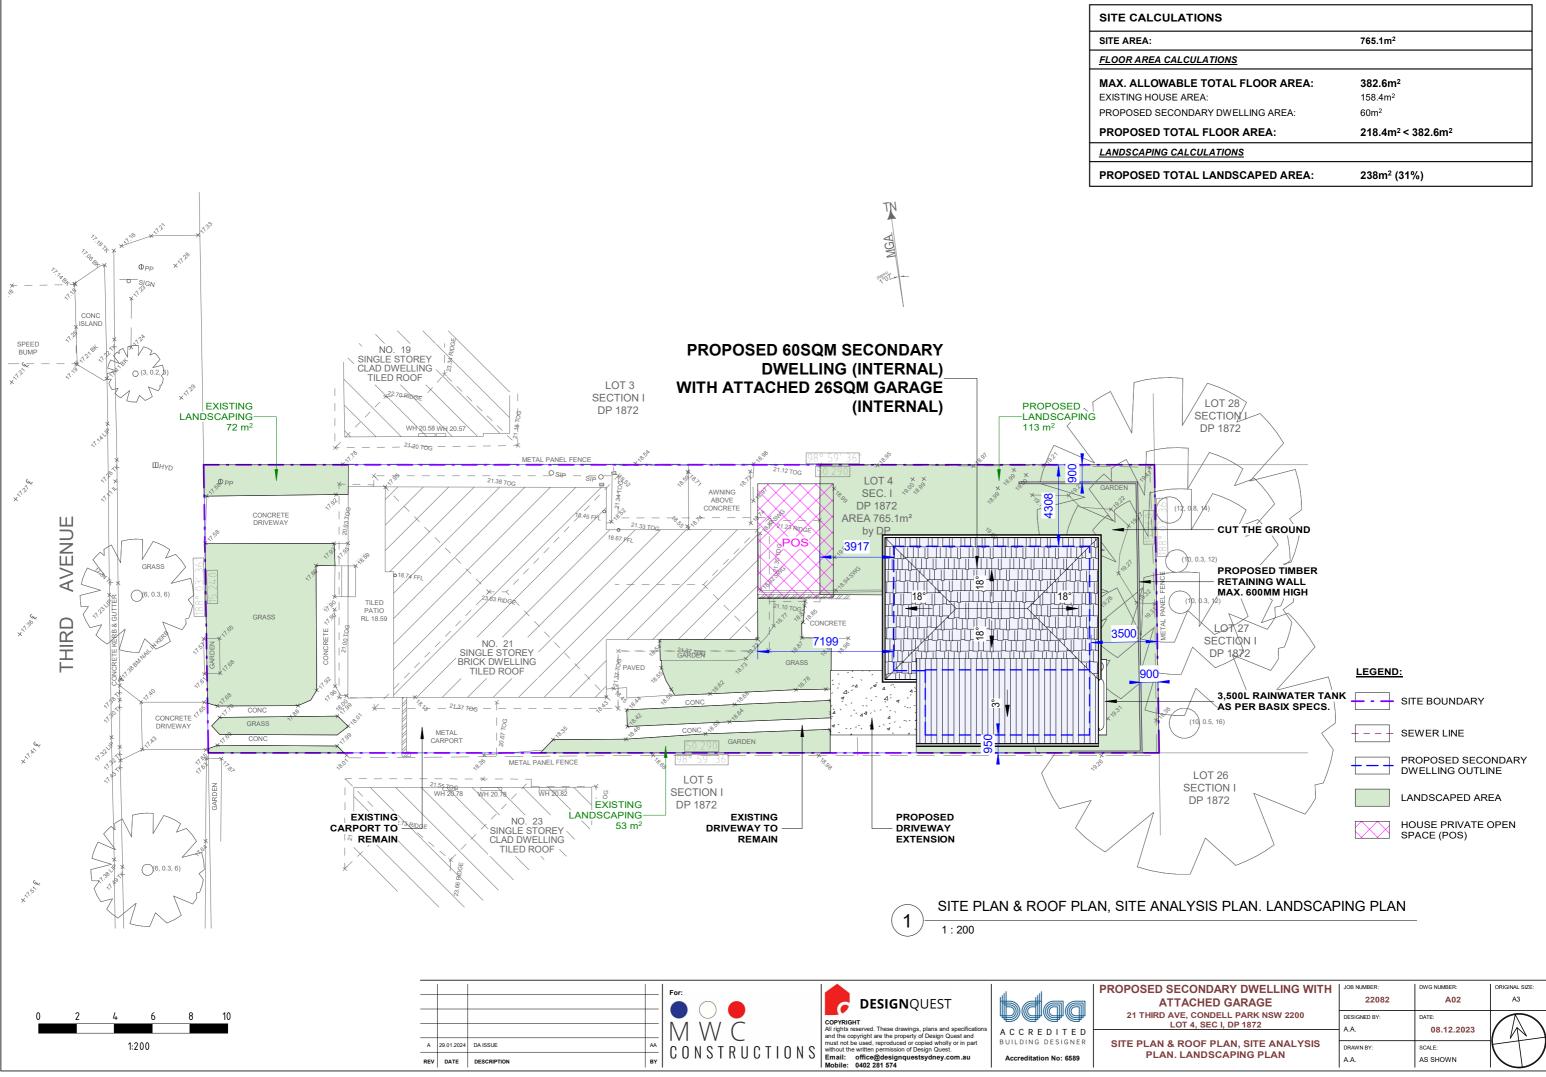

A CONTROL PARTIES	REV	DATE	DESCRIPTION	BY	CONSTRUCTIONS	Ema
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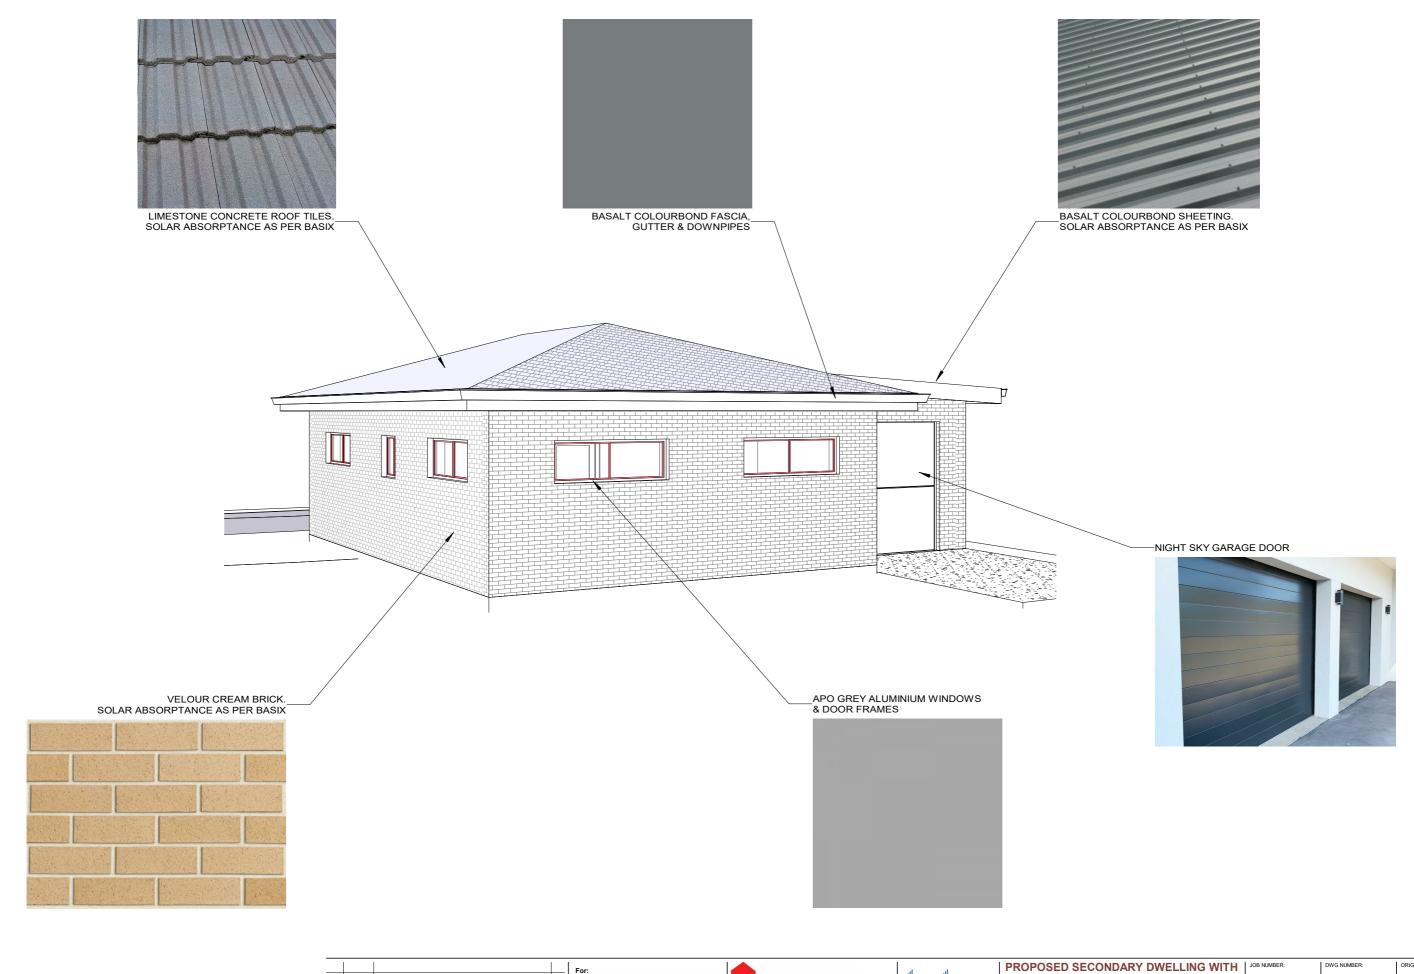
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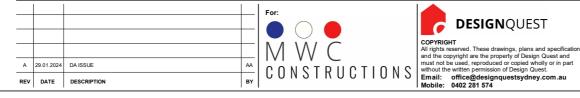
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A C C R E D I T E D BUILDING DESIGNER Accreditation No: 6589	

ROPOSED SECONDARY DWELLING WITH
ATTACHED GARAGE
21 THIRD AVE, CONDELL PARK NSW 2200
LOT 4, SEC I, DP 1872

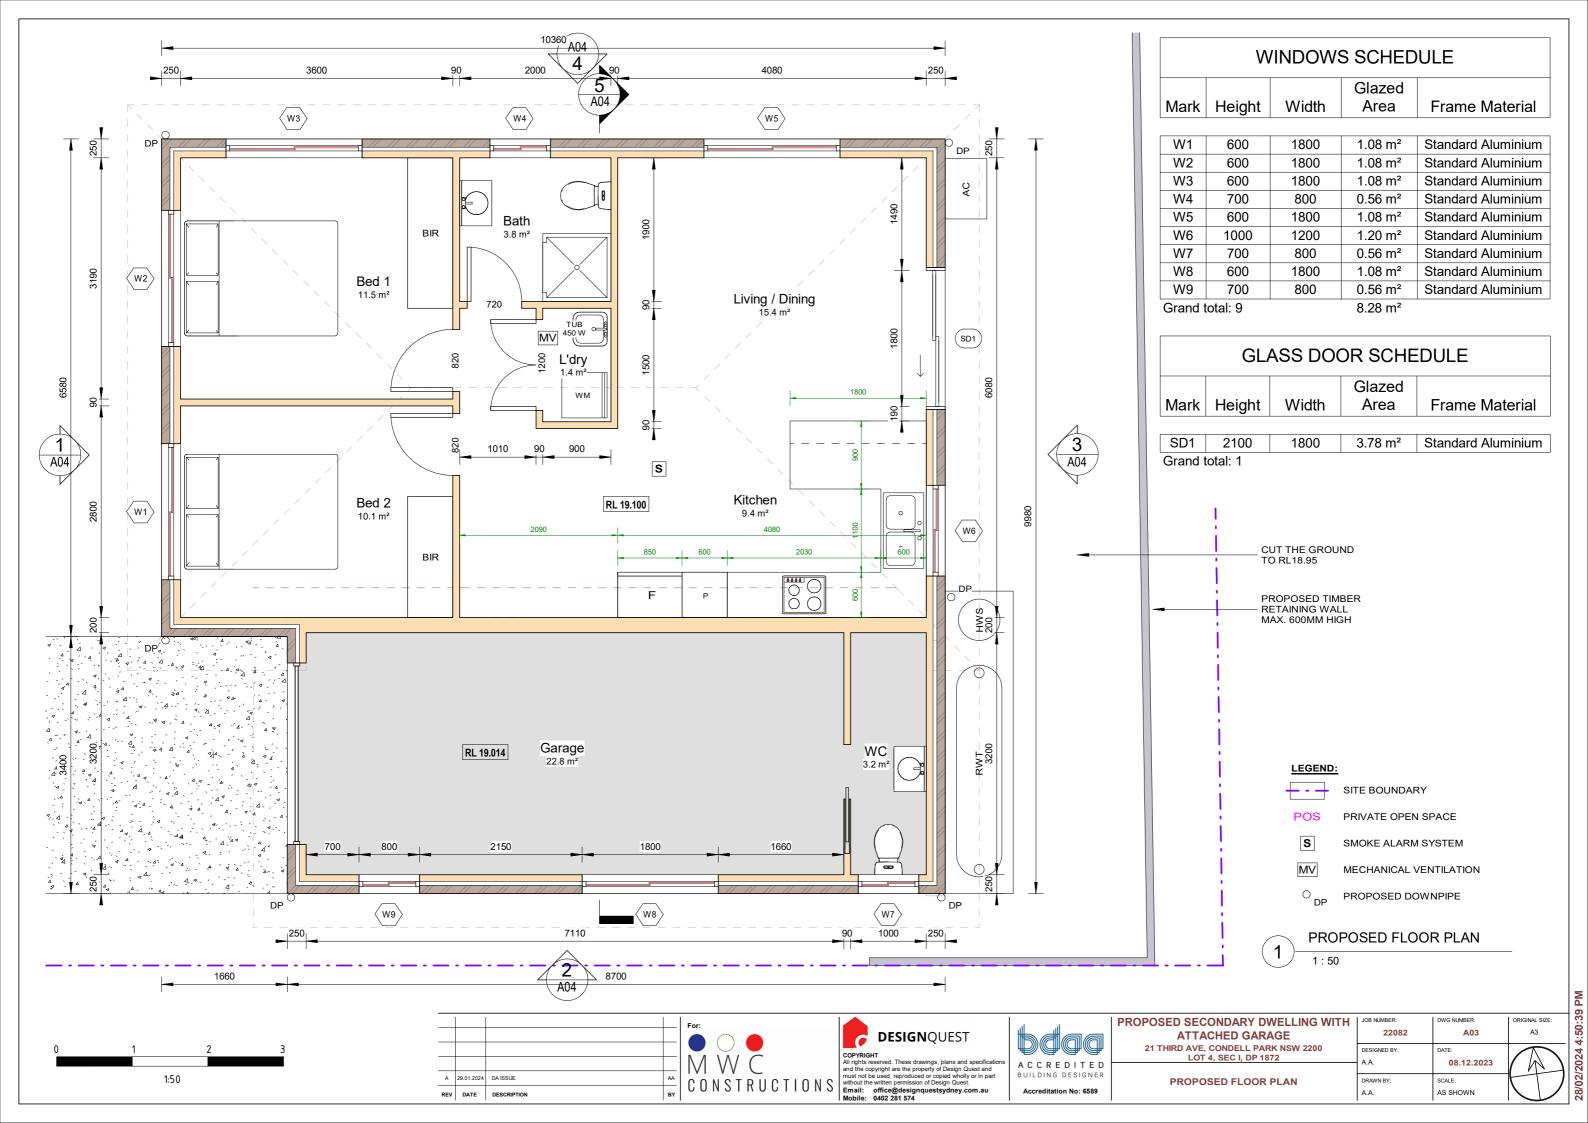3D MODEL

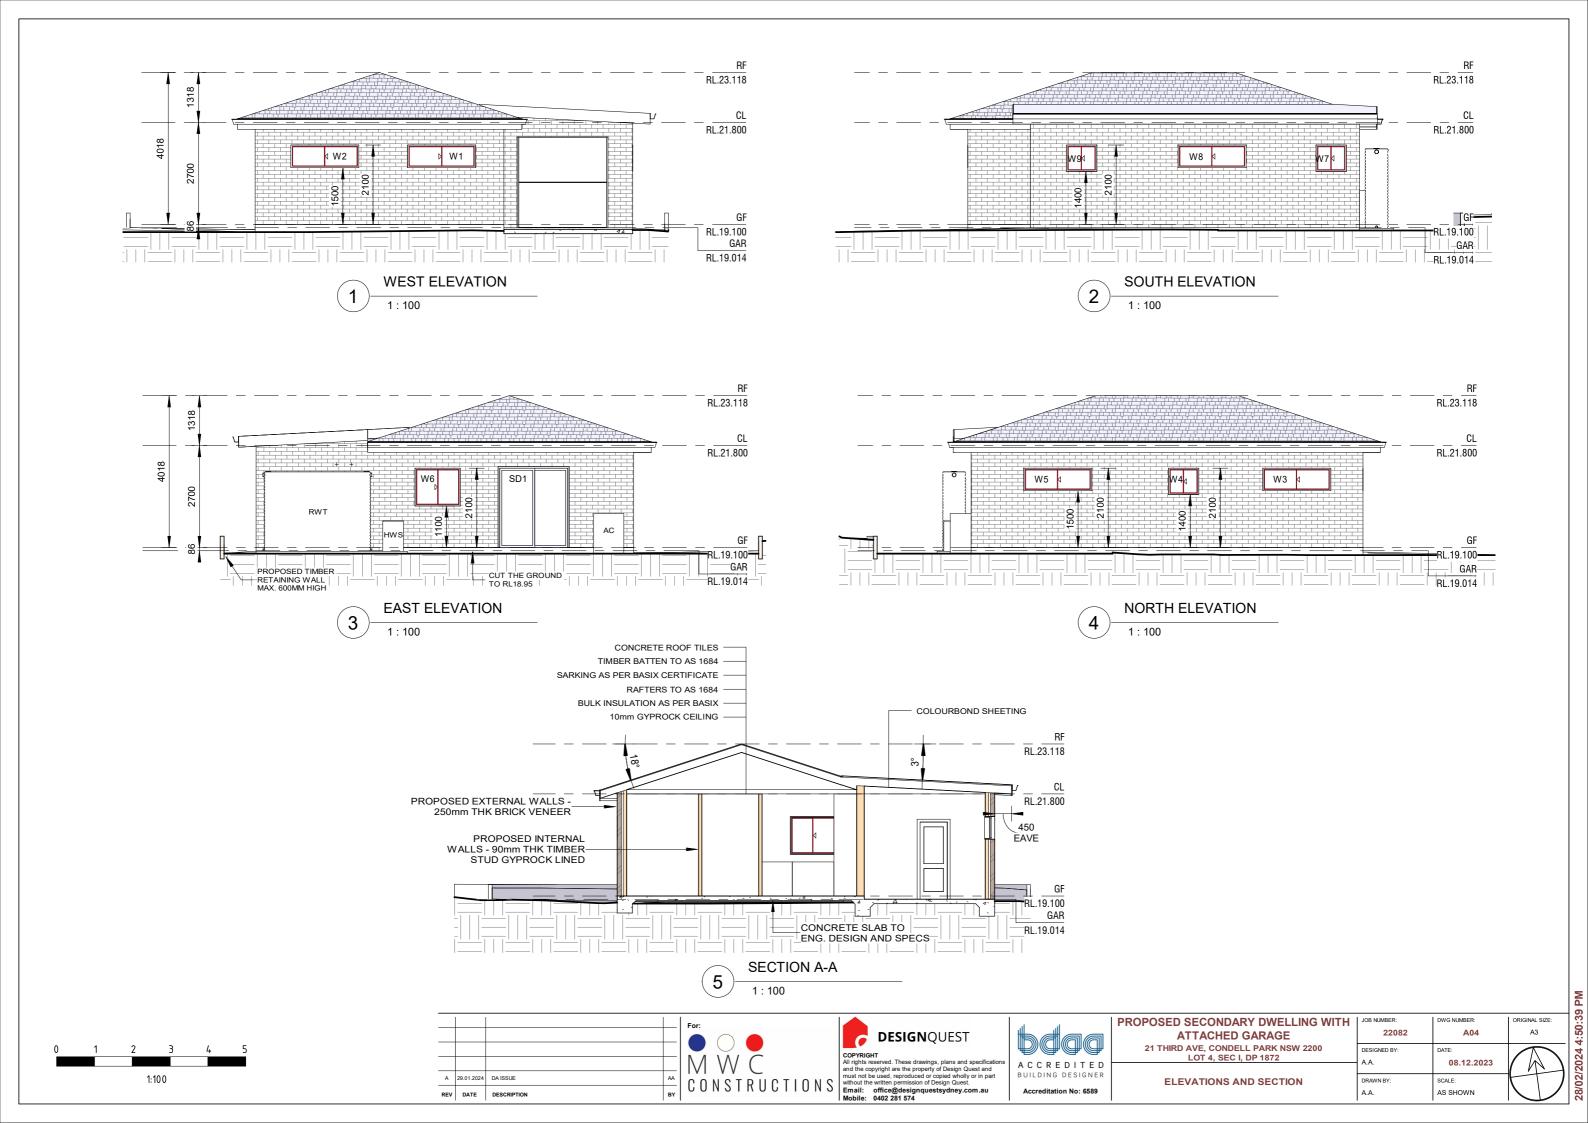Ī	JOB NUMBER:	DWG NUMBER:	ORIGINAL SIZE:
	22082	A05	A3
	DESIGNED BY:	DATE:	
	A.A.	08.12.2023	
	DRAWN BY:	SCALE:	
	A.A.	AS SHOWN	








bdoo	
ACCREDITED BUILDING DESIGNER	l
Accreditation No: 6589	l

ATTACHED GARAGE
21 THIRD AVE, CONDELL PARK NSW 2200
LOT 4, SEC I, DP 1872

SCHEDULE C	F MATERIALS	8 & FINISHES	

Ή	JOB NUMBER: 22082	DWG NUMBER:	ORIGINAL SIZE:
	DESIGNED BY: A.A.	DATE: 08.12.2023	
	DRAWN BY: A.A.	SCALE: AS SHOWN	

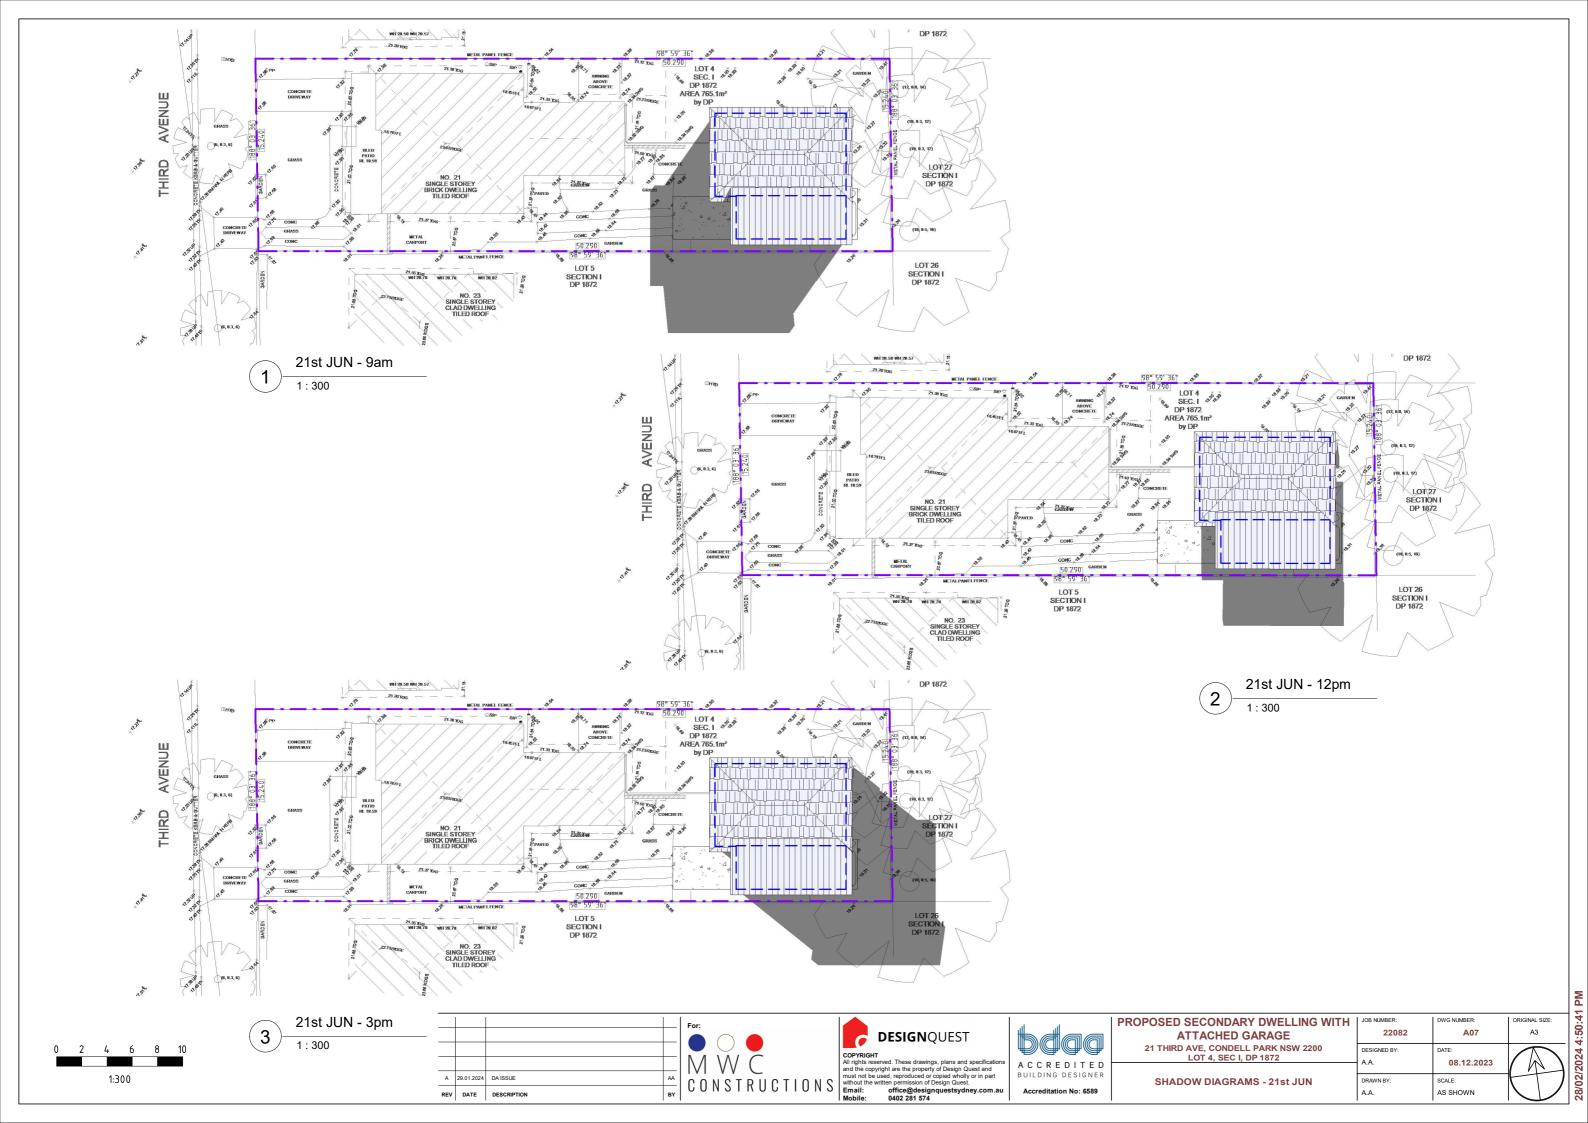

BASIX Certificate Building Sustainability Index www.basix.nsw.gov.au

Single Dwelling

Certificate number: 1736559S_02

This certificate confirms that the proposed development will meet the NSW government's requirements for sustainability, if it is built in accordance with the commitments set out below. Terms used in this certificate, or in the commitments, have the meaning given by the document entitled "BASIX Definitions" dated 10/09/2020 published by the Department. This document is available at www.basix.rsw.gov.au

Secretary
Date of issue: Friday, 23 February 2024
To be valid, this certificate must be lodged within 3 months of the date of issue.



Project summary	
Project name	22082 - 21 Third Ave, Condell Park_02
Street address	21 THIRD Avenue CONDELL PARK 2200
Local Government Area	Canterbury-Bankstown Council
Plan type and plan number	Deposited Plan DP1872
Lot no.	4
Section no.	1
Project type	dwelling house (detached) - secondary dwelling
No. of bedrooms	2
Project score	
Water	✓ 40 Target 40
Thermal Performance	✓ Pass Target Pass
Energy	✓ 70 Target 68
Materials	✓ -1 Target n/a

Certificate Prepared by	
Name / Company Name: DESIGN QUEST SYDNEY PTY LTD	
ABN (if applicable): 40662407810	

Thermal Performance and	Materials commitments		Show on DA plans	Show on CC/CDC plans & specs	Certifier check
Do-it-yourself Method					
General features					
The dwelling must be a Class 1 dw	elling according to the National	Construction Code, and must not have more	than 2 storeys.	~	~
The conditioned floor area of the dwelling must not exceed 300 square metres.				~	~
The dwelling must not contain open mezzanine area exceeding 25 square metres.			~	~	~
The dwelling must not contain third level habitable attic room.				~	_
Floor, walls and ceiling/roof					
The applicant must construct the fle below.	oor(s), walls, and ceiling/roof of	he dwelling in accordance with the specifical	ions listed in the table	~	~
The applicant must adopt one of th ceiling/roof of the dwelling.	e options listed in the tables beli	ow to address thermal bridging in metal frame	ed floor(s), walls and	~	_
The applicant must show through r the tables below.	eceipts that the materials purcha	ased for construction are consistent with the	pecifications listed in		-

timber - untreated softwood.	all external walls	2.44 (or 3.00 including construction);fibreglass batts or roll	nii	absorptance < 0.48)	

Project summary					
Project name	22082 - 21 Third Ave, C	22082 - 21 Third Ave, Condell Park_02			
Street address	21 THIRD Avenue CON	21 THIRD Avenue CONDELL PARK 2200			
Local Government Area	Canterbury-Bankstown (Canterbury-Bankstown Council			
Plan type and plan number	Deposited Plan DP1872	Deposited Plan DP1872			
Lot no.	4				
Section no.	1				
Project type	dwelling house (detache	dwelling house (detached) - secondary dwelling			
No. of bedrooms	2	2			
Project score					
Water	✓ 40	Target 40			
Thermal Performance	✓ Pass	Target Pass			
Energy	✓ 70	Target 68			
Materials	✓ -1	Target n/a			

Street address	21 THIRD Avenue CONDELL PARK 2200
Local Government Area	Canterbury-Bankstown Council
Plan type and plan number	Deposited Plan DP1872
Lot no.	4
Section no.	I
Project type	
Project type	dwelling house (detached) - secondary dwelling
No. of bedrooms	2
Site details	
Site area (m²)	765
Roof area (m²)	123
Conditioned floor area (m²)	61.6
Unconditioned floor area (m²)	6.2
Total area of garden and lawn (m²)	100
Roof area of the existing dwelling (m²)	279
Number of bedrooms in the existing dwelling	4

Description of project

n/a	
n/a	
n/a	
n/a	
✓ 40	Target 40
✓ Pass	Target Pass
✓ 70	Target 68
✓ =1	Target n/a
	n/a n/a n/a n/a v 40 v Pass v 70

Construction	Area - m²	Additional insulation required	Options to address thermal bridging	Other specifications
nternal wall shared with garage: plasterboard; frame: timber - untreated softwood.	23	nil;fibreglass batts or roll	nil	
nternal wall: plasterboard; frame: timber - untreated softwood.	49.4	fibreglass batts or roll	nil	
ceiling and roof - flat ceiling / pitched roof, framed - concrete tiles , timber - untreated softwood.	78.5	ceiling: 4 (up), roof: foil/ sarking ;ceiling: fibreglass batts or roll; roof: foil/sarking.	nil	roof space ventilation: wind- driven ventilator(s) + eave vents roof colour: medium (solar absorptance 0.48-0.59); ceiling area fully insulated
ceiling and roof - flat ceiling / flat roof, framed - metal roof, timber - untreated softwood.	44.1	ceiling: 4 (up), roof: foil/ sarking ;ceiling: fibreglass batts or roll; roof: foil/sarking.	nil	roof colour: medium (solar absorptance 0.48-0.59); ceiling area fully insulated

Construction	Area - m²	Additional insulation required	Options to address thermal bridging	Other specifications
internal wall shared with garage: plasterboard; frame: timber - untreated softwood.	23	nil;fibreglass batts or roll	nil	
internal wall: plasterboard; frame: timber - untreated softwood.	49.4	fibreglass batts or roll	nil	
ceiling and roof - flat ceiling / pitched roof, framed - concrete tiles , timber - untreated softwood.	78.5	ceiling: 4 (up), roof: foil/ sarking ;ceiling: fibreglass batts or roll; roof: foil/sarking.	nil	roof space ventilation: wind- driven ventilator(s) + eave vents; roof colour: medium (solar absorptance 0.48-0.59); ceiling area fully insulated
ceiling and roof - flat ceiling / flat roof, framed - metal roof, timber - untreated softwood.	44.1	ceiling: 4 (up), roof: foil/ sarking ;ceiling: fibreglass batts or roll; roof: foil/sarking.	nil	roof colour: medium (solar absorptance 0.48-0.59); ceiling area fully insulated
		fance with the ABCB Housing Provisio	. ,	
_		ater than R3.0, refer to the ABCB Hous		
		onsideration of condensation and asso	, ,	•
Note • Thermal breaks must be i	nstalled in metal framed walls and app	olicable roofs in accordance with the Al	BCB Housing Provisions of the Nationa	al Construction Code.

Schedule of BASIX commitments

The commitments set out below regulate how the proposed development is to be carried out. It is a condition of any development consent granted, or complying development certificate issued, for the proposed development, that BASIX commitments be complied with.

Water Commitments	Show on DA plans	Show on CC/CDC plans & specs	Certifier check
Fixtures			
The applicant must install showerheads with a minimum rating of 4 star (> 4.5 but <= 6 L/min plus spray force and/or coverage tests) in all showers in the development.		~	~
The applicant must install a toilet flushing system with a minimum rating of 6 star in each toilet in the development.		~	~
The applicant must install taps with a minimum rating of 6 star in the kitchen in the development.		~	
The applicant must install basin taps with a minimum rating of 6 star in each bathroom in the development.		~	
Alternative water			
Rainwater tank			
			-
Rainwater tank The applicant must install a rainwater tank of at least 3500 litres on the site. This rainwater tank must meet, and be installed in	-	~	~
Rainwater tank The applicant must install a rainwater tank of at least 3500 litres on the site. This rainwater tank must meet, and be installed in accordance with, the requirements of all applicable regulatory authorities. The applicant must configure the rainwater tank to collect rain runoff from at least 122.6 square metres of the roof area of the	~	<i>y</i>	~

Thermal Performance and Materials commitments	Show on DA plans	Show on CC/CDC plans & specs	Certifier check
Ceiling fans			
The applicant must install at least one ceiling fan in at least one daytime habitable space, such as living room.	~	~	~
 The minimum number and diameter of ceiling fans in a daytime habitable space must be installed in accordance with the ABCB Housing Provisions (Part 13.5.2) of the National Construction Code. 	~	~	~

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PROPOSED SECONDA
ATTACHE
21 THIRD AVE, COND
LOT 4, SEC

OSED SECONDARY DWELLING WITH ATTACHED GARAGE	JOB NUMBER: 22082	DWG NUMBER:	ORIGINAL SIZE:
1 THIRD AVE, CONDELL PARK NSW 2200 LOT 4, SEC I, DP 1872	DESIGNED BY:	DATE: 08.12.2023	
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BASIX REQUIREMENTS - PART 1	A.A.	AS SHOWN	$\setminus \setminus$

Thermal Performance and Materials commitments	Show on DA plans	Show on CC/CDC plans & specs	Certifier check
Glazed windows, doors and skylights			
The applicant must install the windows, glazed doors and shading devices described in the table below, in accordance with the specifications listed in the table. Relevant overshadowing specifications must be satisfied for each glazed window and door.	~	~	~
The dwelling may have 1 skylight (<0.7 square metres) which is not listed in the table.	~	~	~
The following requirements must also be satisfied in relation to each window and glazed door:	~	~	~
The applicant must install windows and glazed doors in accordance with the height and width, frame and glazing types listed in the table.	~	~	~
 Each window and glazed door must have a U-value no greater than that listed and a Solar Heat Gain Coefficient (SHGC) within the range listed. Total system U values and SHGC must be calculated in accordance with National Fenestration Rating Council (NFRC) conditions. 		~	~
 Overshadowing buildings/vegetation must be of the height and distance from the centre and the base of the window and glazed door, as specified in the 'overshadowing' column. 	~	~	~
The applicant must install the skylights described in the table below, in accordance with the specifications listed in the table. Total skylight area must not exceed 3 square metres (the 3 square metre limit does not include the optional additional skylight of less than 0.7 square metres that does not have to be listed in the table).	~	~	~

Glazed window/door no.	Orientation	Maximum height (mm)	Maximum width (mm)	Frame and glass specification	Shading device (Dimension within 10%)	Overshadowing
W3	N	600.00	1800.00	aluminium, single glazed (U-value: <=7, SHGC: 0.60 - 0.74)	eave 600 mm, 360 mm above head of window or glazed door	not overshadowed
W4	N	700.00	800.00	aluminium, single glazed (U-value: <=7, SHGC: 0.60 - 0.74)	eave 600 mm, 360 mm above head of window or glazed door	not overshadowed
W5	N	600.00	1800.00	aluminium, single glazed (U-value: <=7, SHGC: 0.60 - 0.74)	eave 600 mm, 360 mm above head of window or glazed door	not overshadowed

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aluminium, single glazed (U-value: <=7, SHGC: 0.60 - 0.74) eave 600 mm, 550 above head of wind or glazed door aluminium, single glazed (U-value: <=7, SHGC: 0.60 - 0.74) aluminium, single glazed (U-value: <=7, SHGC: 0.60 - 0.74) eave 600 mm, 550 m above head of windo or glazed door aluminium, single glazed (U-value: <=7, SHGC: 0.60 - 0.74) eave 600 mm, 550 mm above head of window or glazed door aluminium, single glazed (U-value: <=7, SHGC: 0.60 - 0.74) eave 600 mm, 360 mm above head of window or glazed door 1800.00 2-4 m high, 5-8 m away eave 600 mm, 360 mm above head of window or glazed door aluminium, single glazed (U-value: <=7, SHGC: 0.60 - 0.74) 1800.00 2-4 m high, 5-8 m away

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Artificial lighting

Natural lighting

Cooling system

Heating system

The applicant must install the following hot water system in the development, or a system with a higher energy rating: electric heat pump with a performance of 21 to 25 STCs or better.

The applicant must install the following cooling system, or a system with a higher energy rating, in at least 1 living area: 1-phase airconditioning - ducted; Energy rating: 5 star (average zone) The applicant must install the following cooling system, or a system with a higher energy rating, in at least 1 bedroom: 1-phase airconditioning - ducted; Energy rating: 5 star (average zone)

The applicant must install the following heating system, or a system with a higher energy rating, in at least 1 living area: 1-phase airconditioning - ducted; Energy rating: 5 star (average zone)

The applicant must install the following heating system, or a system with a higher energy rating, in at least 1 bedroom: 1-phase airconditioning - ducted; Energy rating: 5 star (average zone)

The applicant must ensure that a minimum of 80% of light fixtures are fitted with fluorescent, compact fluorescent, or light-emitting-diode (LED) lamps.

At least 1 Bathroom: individual fan, ducted to façade or roof; Operation control: manual switch on/off Kitchen: individual fan, ducted to façade or roof; Operation control: manual switch on/off

The applicant must install a window and/or skylight in the kitchen of the dwelling for natural lighting.

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Friday, 23 February 2024

Show on Show on CC/CDC Certifier Check

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Energy Commitments	Show on DA plans	Show on CC/CDC plans & specs	Certifier check
The applicant must install a window and/or skylight in 2 bathroom(s)/toilet(s) in the development for natural lighting.	~	~	~

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Commitments identified with a 💆 in the "Show on DA plans" column must be shown on the plans accompanying the development application for the proposed development (if a development application is to be lodged for the proposed development). Commitments identified with a w in the "Show on CC/CDC plans and specs" column must be shown in the plans and specifications accompanying the application for a construction certificate / complying development certificate for the proposed development. Commitments identified with a vin the "Certifier check" column must be certified by a certifying authority as having been fulfilled, before a final occupation certificate (either interim or final) for the development may be issued.

CONSTRUCTIONS REV DATE DESCRIPTION



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Mobile: 0402 281 574



PROPOSED SECONDARY DWELLING WIT ATTACHED GARAGE 21 THIRD AVE, CONDELL PARK NSW 2200 LOT 4, SEC I, DP 1872

BASIX REQUIREMENTS - PART 2

TH	JOB NUMBER: 22082	DWG NUMBER:	ORIGINAL SIZE:
	DESIGNED BY: A.A.	DATE: 08.12.2023	
	DRAWN BY: A.A.	SCALE: AS SHOWN	

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BUILDING SPECIFICATIONS National Construction Code - Volume 2 -**Building Code of Australia 2022 and Housing Provisions Standard 2022**

SITE PREPARATION

- PART H1D3 OF THE BCA 2022 - VOLUME

- PART 3 OF THE HOUSING PROVISIONS STANDARD 2022

EARTHWORKS

- TO BE CARRIED OUT IN ACCORDANCE WITH THE REQUIREMENTS OF THE ENVIRONMENTAL PLANNING & ASSESSMENT ACT 1979 AND DEVELOPMENT CONSENT CONDITIONS - PART 3.2 OF THE HOUSING PROVISIONS STANDARD 2022 - AS 4678:2002 - EARTH-RETAINING STRUCTURES

DRAINAGE

- PART 3.3 OF THE HOUSING PROVISIONS STANDARD 2022 - AS/NZS 3500.1:2018 - PLUMBING & DRAINAGE - WATER SERVICES - AS/NZS 3500.2:2018 - PLUMBING & DRAINAGE - SANITARY PLUMBING & DRAINAGE - AS/NZS 3500.3:2018 - PLUMBING & DRAINAGE - STORMWATER DRAINAGE - AS/NZS 3500.4:2018 - PLUMBING & DRAINAGE - HEATED WATER SERVICES

STRUCTURAL WORK

- PART H1 OF THE BCA 2022 - VOLUME 2 - AS 4100-1998- STEEL STRUCTURES

- AS/NZS 1170.0-2002 - GENERAL PRINCIPLES

- ASNZS 1170.1-2002 - PARTS 1 PERMANENT, IMPOSED AND OTHER **ACTIONS**

- AS/NZS 1170.2-2011 - PART 2 WIND **ACTIONS**

- AS 3700-2018- SAA MASONRY CODE - AS 1684.3-2010 - RESIDENTIAL TIMBER FRAMED CONSTRUCTION

FOOTINGS & SLABS

- PART H1D4 OF THE BCA 2022 - VOLUME - PART 4 OF THE HOUSING PROVISIONS STANDARD 2022 - AS 2159:2009 - PILING - DESIGN & INSTALLATION - AS 2870:2011 - RESIDENTIAL SLABS & **FOOTINGS** - AS 3600:2018 - CONCRETE **STRUCTURES**

MASONRY

- PART H1D5 OF THE BCA 2022 - VOLUME

- PART 5 OF THE HOUSING PROVISIONS STANDARD 2022

- AS 3700:2018 - MASONRY STRUCTURES

MANAGEMENT SYSTEM

FRAMING

- PART H1D6 OF THE BCA 2022 - VOLUME - PART 6 OF THE HOUSING PROVISIONS STANDARD 2022 - AS 1684.2:2010 - RESIDENTIAL TIMBER FRAMED CONSTRUCTION -NONCYCLONIC AREAS - AS 1720.1:2010 - TIMBER STRUCTURES -DESIGN METHODS
- AS 4100:1998 - STEEL STRUCTURES
- AS 3660.1-2014 - TERMITE

- PART H1D7 OF THE BCA 2022 - VOLUME

- PART 7 OF THE HOUSING PROVISIONS STANDARD 2022 - AS 1273:1991 - UNPLASTICIZED PVC

ROOF & WALL CLADDING

(UPVC) DOWNPIPES & FITTINGS FOR RAINWATER - AS 1562.1:2018 - DESIGN &

INSTALLATION OF SHEET ROOF & WALL CLADDING -METAL

- AS/NZS 1562.2:1999 - DESIGN & INSTALLATION OF SHEET ROOF & WALL CLADDING - CORRUGATED FIBRE REINFORCED CEMENT

- AS/NZS 1562.3:1996 - DESIGN & INSTALLATION OF SHEET ROOF & WALL CLADDING - PLASTIC

- AS 2049:2002 - ROOF TILES - AS 2050:2018 - INSTALLATION OF ROOF

- AS 4285:2019 – ROOFLIGHTS

GLAZING

- PART H1D8 OF THE BCA 2022 - VOLUME

- PART 8 OF THE HOUSING PROVISIONS STANDARD 2022 - AS 1288:2006 - GLASS IN BUILDINGS -SELECTION & INSTALLATION - AS 2047:2014 - WINDOWS & EXTERNAL GLAZED DOORS IN BUILDINGS - AS/NZS 2208:1996 - SAFETY GLAZING MATERIALS IN BUILDINGS

FIRE SAFETY

- PART H3 OF THE BCA 2022 - VOLUME 2 - PART 9 OF THE HOUSING PROVISIONS STANDARD 2022 - AS 3786:2014 - SMOKE ALARMS USING SCATTERED LIGHT, TRANSMITTED LIGHT OR IONIZATION

HEALTH & AMENITY

- PART H4 OF THE BCA 2022 - VOLUME 2 - PART 10 OF THE HOUSING PROVISIONS STANDARD 2022 - AS/NZS ISO 717.1:2004 - ACOUSTICS -RATING OF SOUND INSULATION IN **BUILDINGS & OF BUILDING ELEMENTS -**AIRBORNE SOUND INSULATION - AS ISO 717.2:2004 - ACOUSTICS - RATING OF SOUND INSULATION IN BUILDINGS & OF BUILDING ELEMENTS - IMPACT SOUND - AS 1668.2:2012 - THE USE OF VENTILATION & AIR CONDITIONING IN BUILDINGS - MECHANICAL VENTILATION IN BUILDINGS - AS 1668.4:2012 - THE USE OF VENTILATION & AIR CONDITIONING IN **BUILDINGS - NATURAL VENTILATION OF** BUILDINGS - AS/NZS 1680.0:2009 - INTERIOR LIGHTING - SAFE MOVEMENT - AS 3740:2010 - WATERPROOFING OF DOMESTIC WET AREAS - AS 3000-2018 - ELECTRICAL

WATERPROOFING

INSTALLATION

- PART H2 OF THE BCA 2022 - VOLUME 2 - PART 10.2 OF THE HOUSING PROVISIONS STANDARD 2022 - AS 3740-2010 - WATERPROOFING TO - AS 4654-2012 – EXTERNAL WET AREAS

SAFE MOVEMENT & ACCESS

- PART H5 OF THE BCA 2022 - VOLUME 2 - PART 11 OF THE HOUSING PROVISIONS STANDARD 2022 - AS 1428.1:2009 - DESIGN FOR ACCESS & MOBILITY - GENERAL REQUIREMENTS FOR ACCESS - NEW BUILDING WORK - AS 1657:2018 - FIXED PLATFORMS WALKWAYS, STAIRWAYS & LADDERS -**DESIGN, CONSTRUCTION &** INSTALLATION

HANDRAILS & BALUSTRADE

- PART H5D3 OF THE BCA 2022 - VOLUME

- PART 11.3 OF THE HOUSING PROVISIONS STANDARD 2022 - AS 1170.1-2002 – BALUSTRADE INSTALLATION

PROTECTION OF OPENABLE WINDOW

- PART 11.3.7 & 11.3.8 OF THE HOUSING PROVISIONS STANDARD 2022

DEMOLITION

- AS 2601-2001 - DEMOLITION WORK

SWIMMING POOL

- PART H7F1, H7P1, H7P2 & H7D2 OF THE BCA 2022 - VOLUME 2 PART 13.7.8 OF THE HOUSING
PROVISIONS STANDARD 2022
- AS 1926 PART 1-2012 – SWIMMING POOL
SAFETY- SAFETY BARRIERS FOR SWIMMING POOLS - AS 1926 PART 2-2007 - SWIMMING POOL SAFETY-LOCATION OF SAFETY BARRIERS FOR SWIMMING POOLS (INCORPORATING AMENDMENTS 1 AND 2) - AS 1926 PART 3-2010 - SWIMMING POOL SAFETY- WATER RECIRCULATION SYSTEMS (INCORPORATING AMENDMENT 1)

ENERGY EFFICIENCY

- PART H6 OF THE BCA 2022 - VOLUME 2 - PART 13 OF THE HOUSING PROVISIONS STANDARD 2022 & BASIX CERTIFICATE

General Notes:

- All work to be carried out according to relevant Australian standards / codes and good building practice.
- Builder to verify all measurements and materials before the commencement of any work.
- Builder to verify and maintain any internal load bearing walls where applicable. Builder to verify and match existing roof pitch where applicable.
- All fixings, fasteners and connections shall comply with manufacturers / engineers specifications. All steel columns, support beams and / or structure shall comply with engineers specifications.
- All framing and bracings shall comply with AS 1684.2-2010 or relevant Australian standards. All r.c. concrete slabs and footings to be to engineers specifications.

 All masonry tie down and bonding beams to be to engineers specifications.

- All masonry construction shall comply with current BCA.
- All wet areas and waterproofing shall comply with current BCA.
- Sub-floor ventilation as per current BCA.
- Wind rating to be nominated by engineer / council u.n.o.

 Bushfire zoning and specifications to be nominated by council / RFS u.n.o.
- Mining Subsidence zoning and specifications to be nominated by council u.n.o. Waste / stormwater catchment and sewage disposal to local council requirements.
- Smoke Detection units shall be installed as per current BCA.
- Termite protection to local council requirements.

 Refer to additional building specifications for further details where applicable.
- Refer to Basix spec for additional requirements where applicable.
- RL levels nominal design only. Actual Surveyed levels to take precedence
- Suggested layout only.
- Do not scale.

				For:
A	29.01.2024	DA ISSUE	AA	CONSTRUCTIONS
REV	DATE	DESCRIPTION	BY	







PROPOSED SECONDARY DWELLING WITH	J
ATTACHED GARAGE	
21 THIRD AVE, CONDELL PARK NSW 2200	D

NOTES &	SPECIFICATIONS

DWG NUMBER:	ORIGINAL SIZE:
A10	A3
DATE:	
08.12.2023	/ N
SCALE:	
AS SHOWN	
	A10 DATE: 08.12.2023 SCALE:

4:50:46